





IMPORTANT NOTES THIS DRAWING IS COPYONICH. LICENCE IS GRANTED ONLY TO THE NAMED CLIENT AND THEIR REPRESENTATIVES TO SUCH EXTENT AS TO ALLOW THE SPECIFIC WORKS ON THE SPECIFIC BY THE DECOMPTIGHT OF THE SUBJECT OF THE SPECIFIC DECOMPTIGHT OF TO THE SPECIFIC DECOMPTIGHT OF TO THE SPECIFIC DECOMPTIGHT OF TO THE SPECIFIC DECOMPTIGHT OF THE SPECIFICATIONS OF THE SPECIFIC DECOMPTIGHT OF THE SPECIFICATIONS THEREON AGAINST THE SITE. ITS GEOMETERY AND CONDITIONS, PRIOR TO THE CARRYING OUT OF THE WORKS.

0	TENDER		
ISSUE	DETAILS		

			CLIENT	SINEAD KEATING	PROJECT NO	SCALE As indicated	
			PROJECT	EXTENSION & ALTERATIONS TO EXISTING COTTAGE BO CHOILL ROAD, MAGANEY.	T20/058	DATE 29/07/2021	$(\land \circ)$
CD	JD	29/07/2021		CO. KILDARE	DRAWING NO	PROJECT PHASE	
СНК	DRN	DATE	DRAWING	EXISTING PLANS & ELEVATIONS	02/01	TENDER	

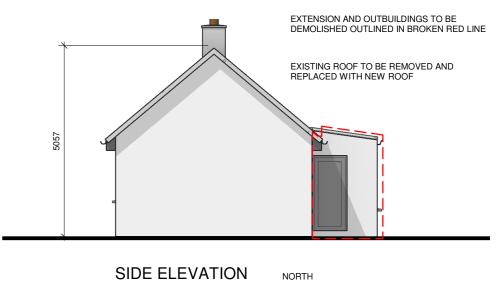

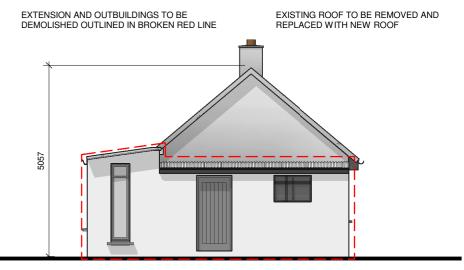


SOUTH

SIDE ELEVATION

1:100


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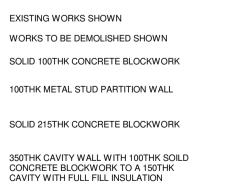
FOUNDATION & DRAINAGE LAYOUT SCALE 1:50

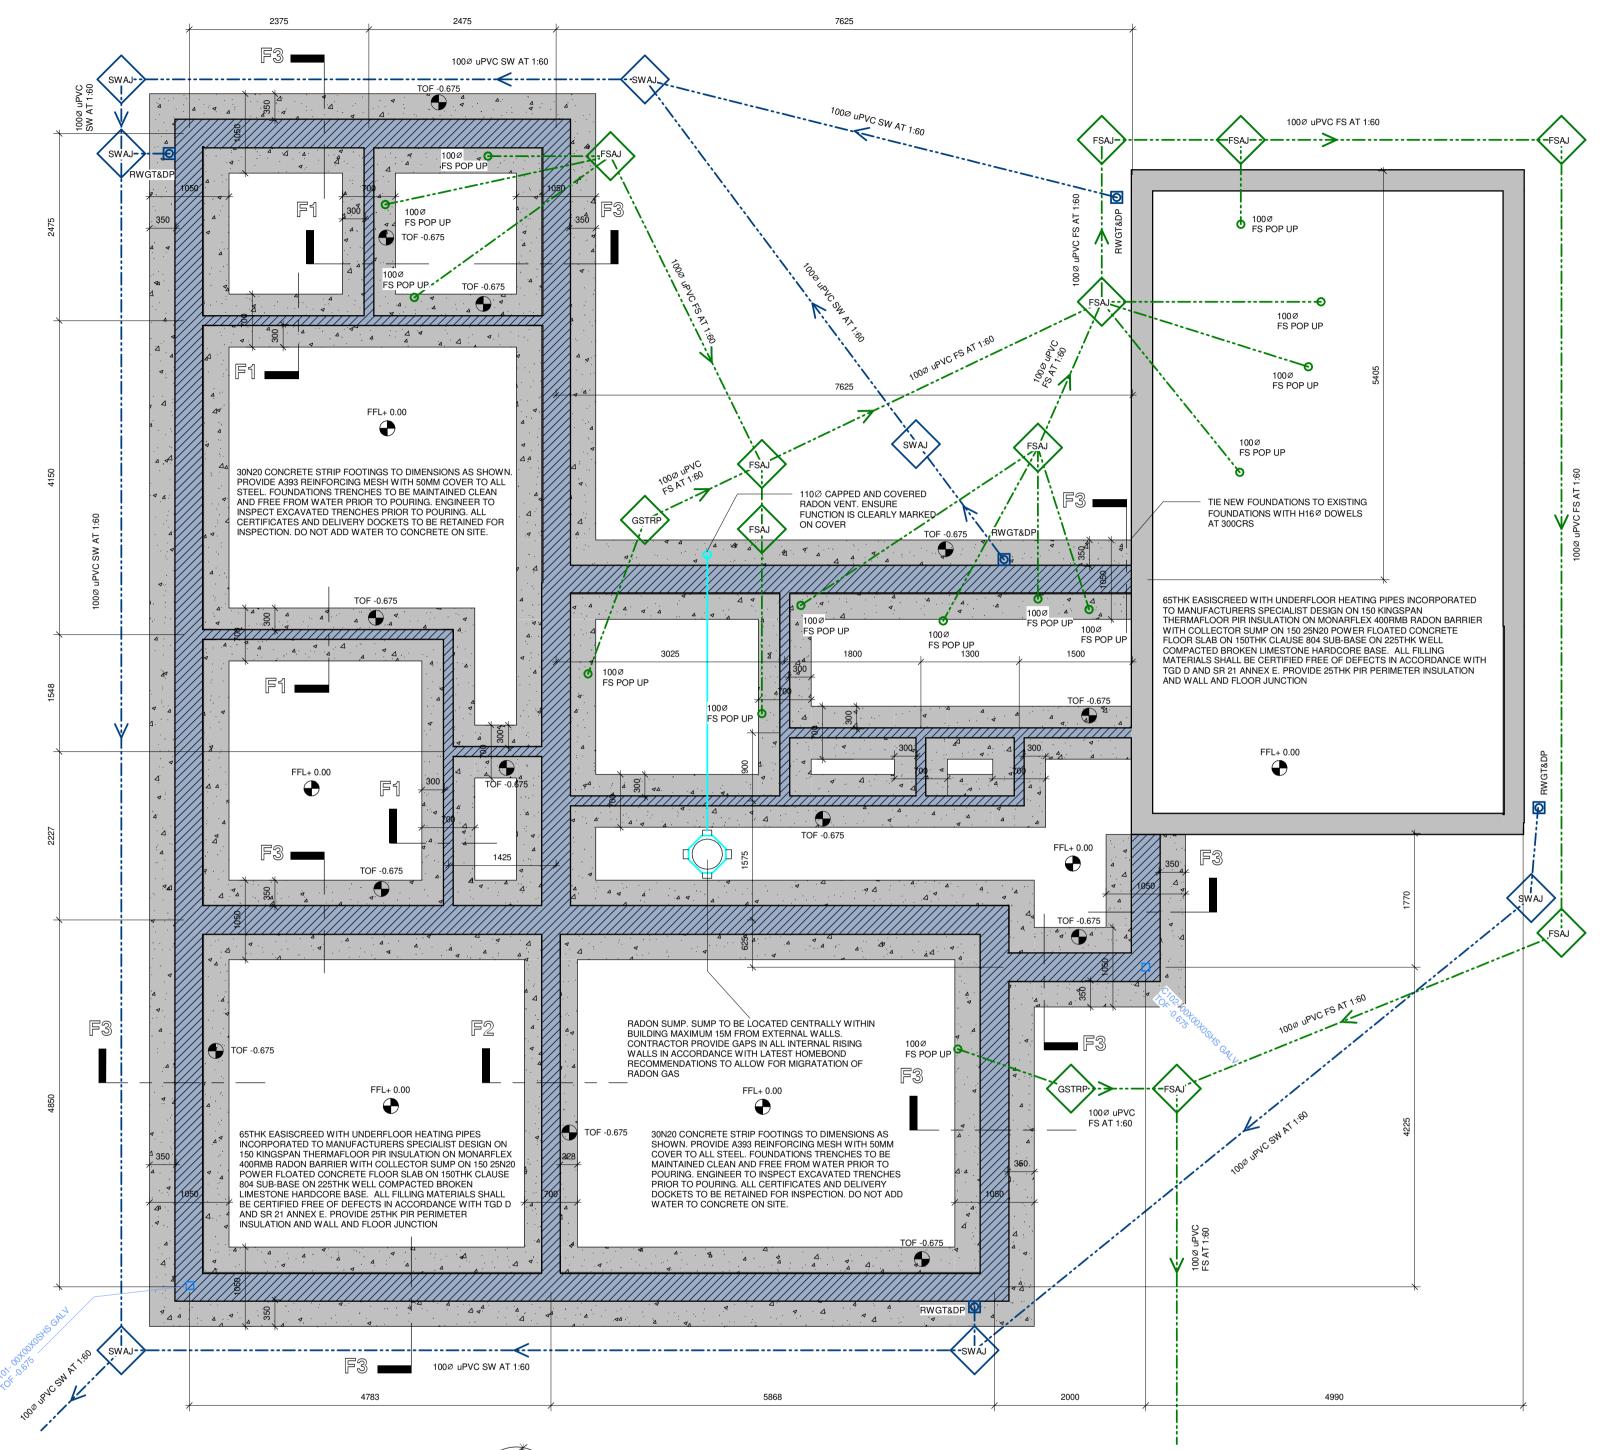
LINEWORK LEGEND

IN



WALL LEGEND

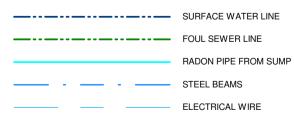

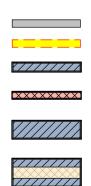




	CD	JD	29/07/20	
	СНК	DRN	DATE	
SINEAD KEATIN	NG			
EXTENSION & ALTERATIONS TO EXISTING COTTAGE BO CHOILL ROAD, MAGANEY, CO. KILDARE				
FOUNDATION & D	RAINAGE LA	YOUT		


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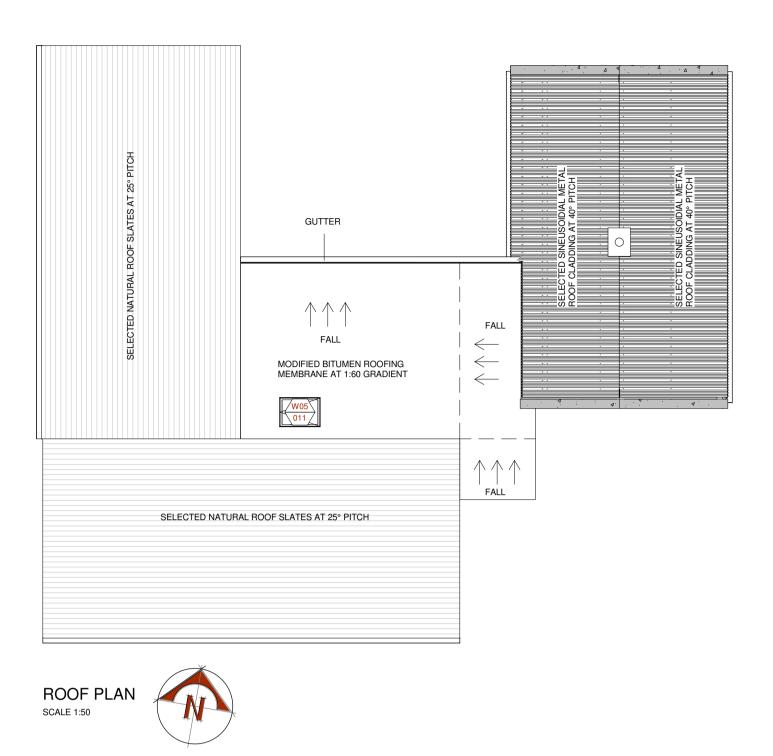


DATE 29/07/2021

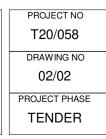

350THK CAVITY WALL WITH 100THK SOILD CONCRETE BLOCKWORK TO A 150THK CAVITY WITH FULL FILL INSULATION

1111111

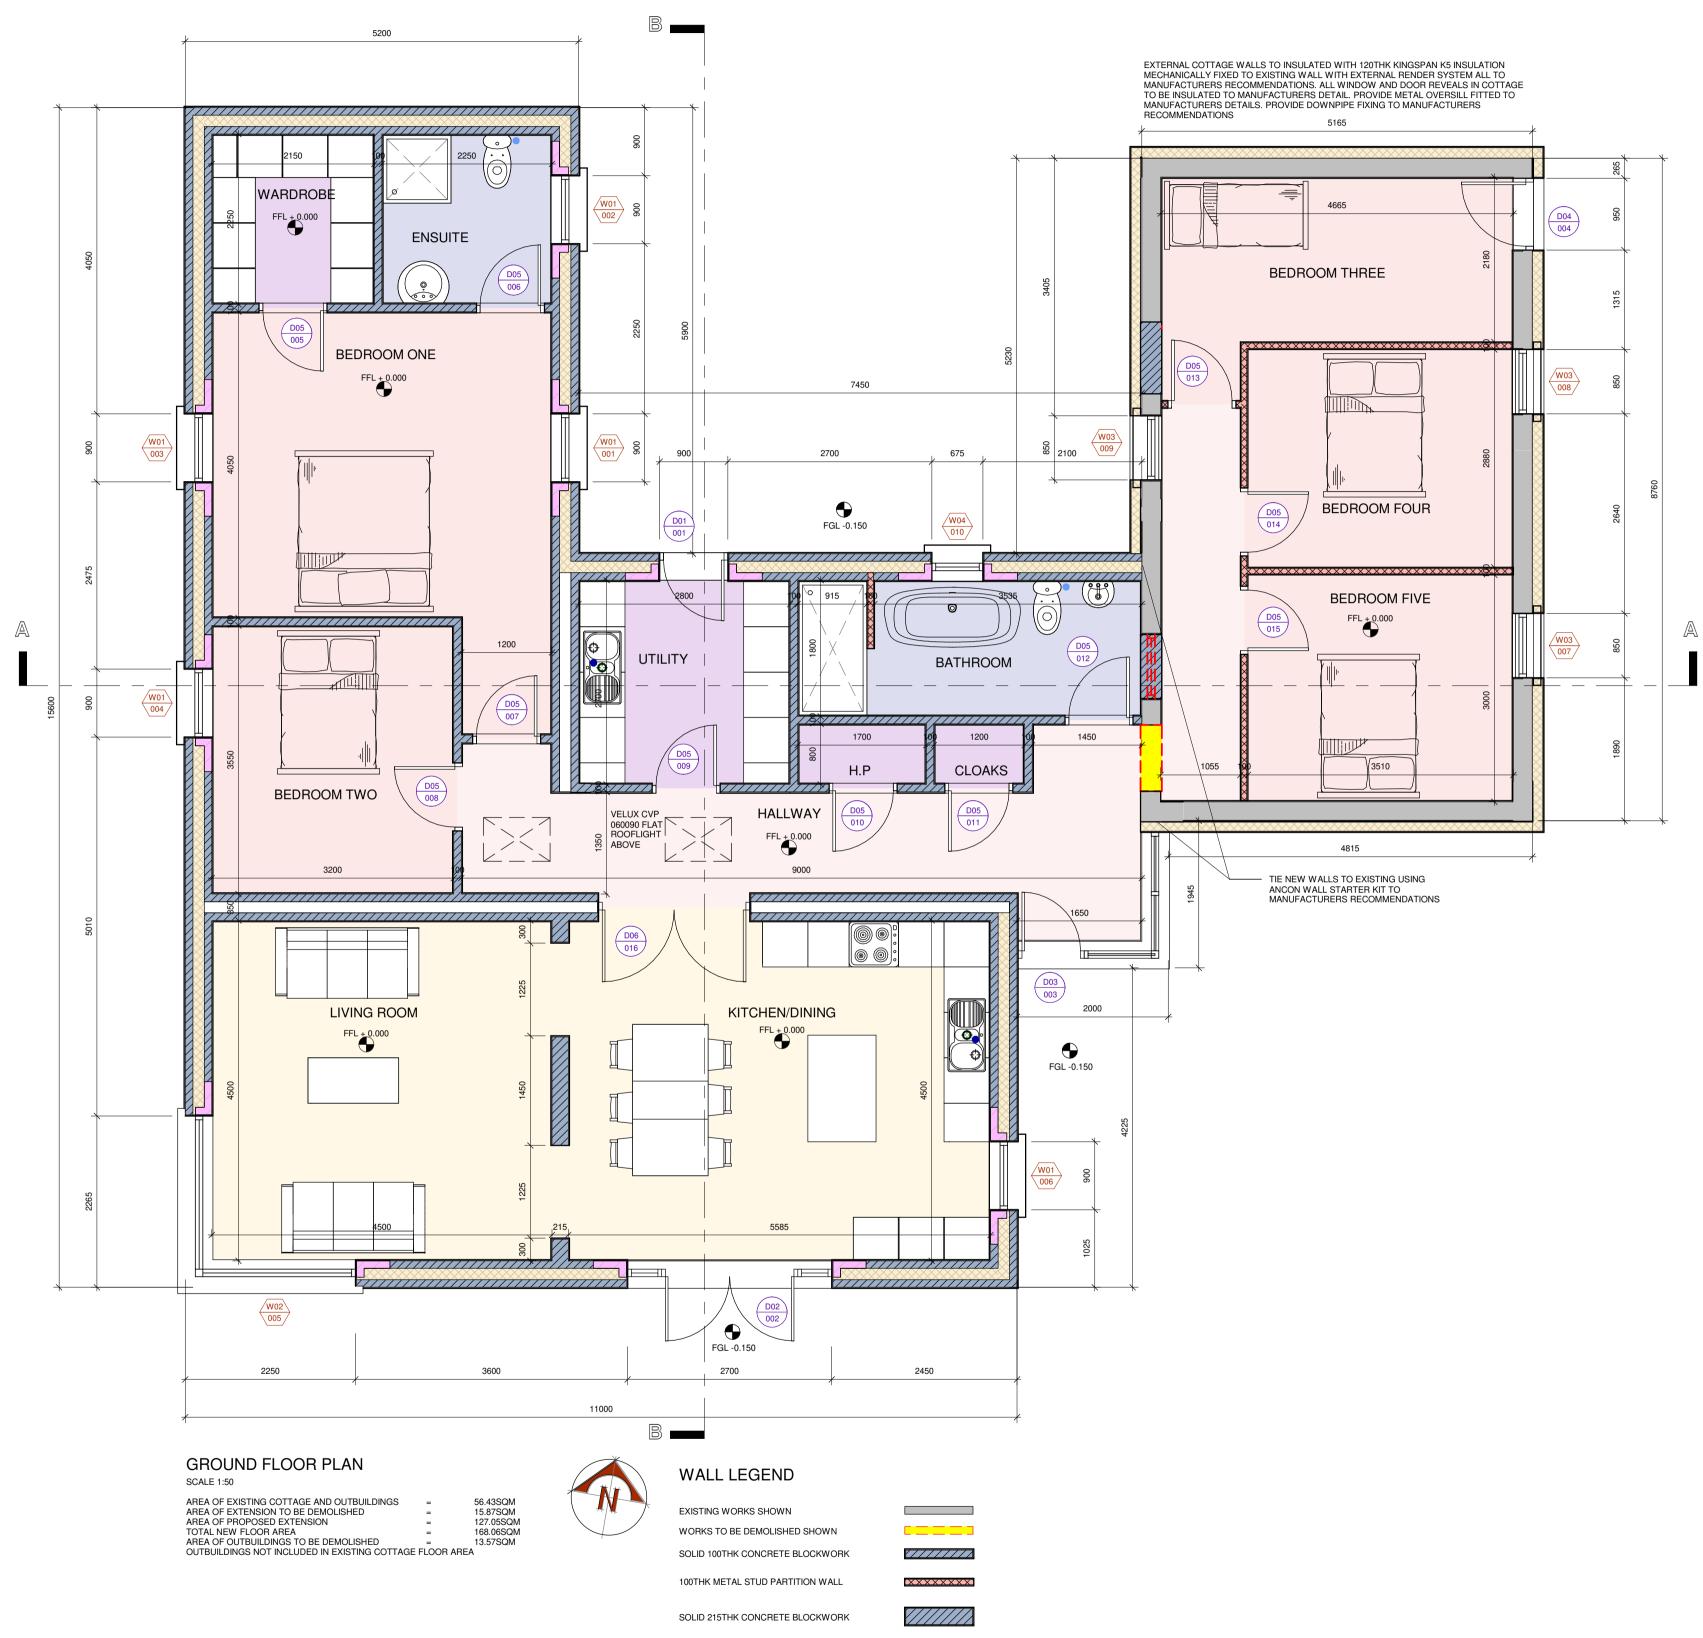

	ROOM SCHEDULE							
NAME	AREA	WALL FINISH	FLOOR FINISH	CEILING FINISH	TRIMS			
HALLWAY	21 m²	3 COATS DULUX MODA EMULSION IN SELECTED COLOUR	ENGINEERED HARDWOOD SELECTED BY CLIENT	3 COATS WHITE DULUX CEILING PAINT	145 X 18MM AMERICAN WHITE OAK HARDWOOD SQUARE EDGED. 90 X 22MM AMERICAN WHITE OAK ARCHITRAVES TO MATCH SKIRTING			
UTILITY	7 m²	3 COATS DULUX MODA EMULSION IN SELECTED COLOUR	FLOOR TILES SELECTED BY CLIENT	3 COATS WHITE DULUX CEILING PAINT	145 X 18MM AMERICAN WHITE OAK HARDWOOD SQUARE EDGED. 90 X 22MM AMERICAN WHITE OAK ARCHITRAVES TO MATCH SKIRTING			
BATHROOM	8 m²	FLOOR TO CEILING 150X150 CERAMIC WALL TILES, WITH SELECTED SKIRTING AND DADO TILES	300X300 NON-SLIP(R12) FLOOR TILES. LEVEL WET ROOM TYPE SHOWERS TO BE TILED TO MATCH WITH MACALPINE STAINLESS STEEL TRAPS	3 COATS WHITE DULUX CEILING PAINT	SELECTED DADO TILES			
KITCHEN/DINING	25 m²	3 COATS DULUX MODA EMULSION IN SELECTED COLOUR	ENGINEERED HARDWOOD SELECTED BY CLIENT	3 COATS WHITE DULUX CEILING PAINT	145 X 18MM AMERICAN WHITE OAK HARDWOOD SQUARE EDGED. 90 X 22MM AMERICAN WHITE OAK ARCHITRAVES TO MATCH SKIRTING			
LIVING ROOM	20 m²	3 COATS DULUX MODA EMULSION IN SELECTED COLOUR	CARPET SELECTED BY CLIENT	3 COATS WHITE DULUX CEILING PAINT	145 X 18MM AMERICAN WHITE OAK HARDWOOD SQUARE EDGED. 90 X 22MM AMERICAN WHITE OAK ARCHITRAVES TO MATCH SKIRTING			
WARDROBE	5 m²	3 COATS DULUX MODA EMULSION IN SELECTED COLOUR	CARPET SELECTED BY CLIENT	3 COATS WHITE DULUX CEILING PAINT	NONE			
ENSUITE	5 m²	FLOOR TO CEILING 150X150 CERAMIC WALL TILES, WITH SELECTED SKIRTING AND DADO TILES	300X300 NON-SLIP(R12) FLOOR TILES. LEVEL WET ROOM TYPE SHOWERS TO BE TILED TO MATCH WITH MACALPINE STAINLESS STEEL TRAPS	3 COATS WHITE DULUX CEILING PAINT	SELECTED DADO TILES			
BEDROOM ONE	20 m ²	3 COATS DULUX MODA EMULSION IN SELECTED COLOUR	CARPET SELECTED BY CLIENT	3 COATS WHITE DULUX CEILING PAINT	145 X 18MM AMERICAN WHITE OAK HARDWOOD SQUARE EDGED. 90 X 22MM AMERICAN WHITE OAK ARCHITRAVES TO MATCH SKIRTING			
BEDROOM TWO	11 m²	3 COATS DULUX MODA EMULSION IN SELECTED COLOUR	CARPET SELECTED BY CLIENT	3 COATS WHITE DULUX CEILING PAINT	145 X 18MM AMERICAN WHITE OAK HARDWOOD SQUARE EDGED. 90 X 22MM AMERICAN WHITE OAK ARCHITRAVES TO MATCH SKIRTING			
CLOAKS	1 m²	3 COATS DULUX MODA EMULSION IN SELECTED COLOUR	ENGINEERED HARDWOOD SELECTED BY CLIENT	3 COATS WHITE DULUX CEILING PAINT	NONE			
BEDROOM THREE	11 m²	3 COATS DULUX MODA EMULSION IN SELECTED COLOUR	CARPET SELECTED BY CLIENT	3 COATS WHITE DULUX CEILING PAINT	145 X 18MM AMERICAN WHITE OAK HARDWOOD SQUARE EDGED. 90 X 22MM AMERICAN WHITE OAK ARCHITRAVES TO MATCH SKIRTING			
BEDROOM FOUR	10 m ²	3 COATS DULUX MODA EMULSION IN SELECTED COLOUR	CARPET SELECTED BY CLIENT	3 COATS WHITE DULUX CEILING PAINT	145 X 18MM AMERICAN WHITE OAK HARDWOOD SQUARE EDGED. 90 X 22MM AMERICAN WHITE OAK ARCHITRAVES TO MATCH SKIRTING			
BEDROOM FIVE	10 m ²	3 COATS DULUX MODA EMULSION IN SELECTED COLOUR	CARPET SELECTED BY CLIENT	3 COATS WHITE DULUX CEILING PAINT	145 X 18MM AMERICAN WHITE OAK HARDWOOD SQUARE EDGED. 90 X 22MM AMERICAN WHITE OAK ARCHITRAVES TO MATCH SKIRTING			
H.P	1 m²	3 COATS DULUX MODA EMULSION IN SELECTED COLOUR	ENGINEERED HARDWOOD SELECTED BY CLIENT	3 COATS WHITE DULUX CEILING PAINT	NONE			

WINDOW TYPE	WINDOW NO.S	SIZE(WIDTHXDEPTH)	
W01	001, 002, 003, 004, 006	900X2100	TRIPLE, SOFT
W02	005	2250X2100	TRIPLE, SOFT
W03	007, 008, 009	850X1100	TRIPLE, SOFT
W04	010	675X2100	TRIPLE, SOFT
W05	011	780X1080	TRIPLE, SOFT

DOOR TYPE	DOOR NO.' S	SIZE(WIDTHXDEPTH)	
D01	001	900X2100	ALUCLAD GLA
D02	002	2700X2100	ALUCLAD GLA
D03	003	875X2050	ALUCLAD GLA
D04	004	950X2100	ALUCLAD DOO
D05	005, 006, 007, 008, 009, 010, 011, 012, 013, 014, 015	900X2100	MOULDED MD
D06	016	2000X2100	MOULDED MD

0	TENDER				CD	JD	29/07/2021
ISSUE	ISSUE DETAILS			СНК	DRN	DATE	
_	STANHOPE ST.,		CLIENT	SINEAD KEATIN	NG		
		ATHY, CO. KILDARE TEL: (059) 8640013 FAX: (059) 8640012 info@mcdcivil.ie	PROJECT	EXTENSION & ALTER BO CHOILL ROAD, MAGANEY, CO. KILDARE FLOOR PLAN & SO		KISTING COTTA	GE

WINDOW SCHEDULE

 GLAZING
 NOTES

 E, SOFT COAT LOW E, ARGON FILLED, CLEAR
 ALUCLAD TILT & TURN WINDOW WITH STAINLESS STEEL IRONMONGERY (U VALUE 0.7W/M2K)

 SOFT COAT LOW E, ARGON FILLED, CLEAR
 ALUCLAD TILT & TURN WINDOW WITH STAINLESS STEEL IRONMONGERY (U VALUE 0.7W/M2K)

 SOFT COAT LOW E, ARGON FILLED, CLEAR
 ALUCLAD TILT & TURN WINDOW WITH STAINLESS STEEL IRONMONGERY (U VALUE 0.7W/M2K)

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 ALUCLAD TILT & TURN WINDOW WITH STAINLESS STEEL IRONMONGERY (U VALUE 0.7W/M2K)

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 ALUCLAD TILT & TURN WINDOW WITH STAINLESS STEEL IRONMONGERY (U VALUE 0.7W/M2K)

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 ALUCLAD TILT & TURN WINDOW WITH STAINLESS STEEL IRONMONGERY (U VALUE 0.7W/M2K)

 SOFT COAT LOW E, ARGON FILLED, CLEAR
 ALUCLAD TILT & TURN WINDOW WITH STAINLESS STEEL IRONMONGERY (U VALUE 0.7W/M2K)

 SOFT COAT LOW E, ARGON FILLED, CLEAR
 ALUCLAD TILT & TURN WINDOW WITH STAINLESS STEEL IRONMONGERY (U VALUE 0.7W/M2K)

DOOR SCHEDULE

NOTES LAZED DOOR. TRIPLE LOW E GLAZING, CLEAR, STAINLESS STEEL IRONMONGERY. GLAZED DOUBLE PATIO DOORS WITH SIDELIGHTS. TRIPLE LOW E GLAZING, CLEAR, STAINLESS STEEL IRONMONGERY. GLAZED DOOR & CORNER WINDOW. TRIPLE LOW E GLAZING, CLEAR, STAINLESS STEEL IRONMONGERY. DOR WITH GLAZED TOP SECTION. TRIPLE LOW E GLAZING, CLEAR, STAINLESS STEEL IRONMONGERY. MDF ENGINEERED INTERNAL SOLID DOOR

MDF ENGINEERED INTERNAL DOUBLE DOORS


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PROJECT NO T20/058 DRAWING NO 02/03 PROJECT PHASE TENDER



As indicated DATE 29/07/2021




SCALE 1:50

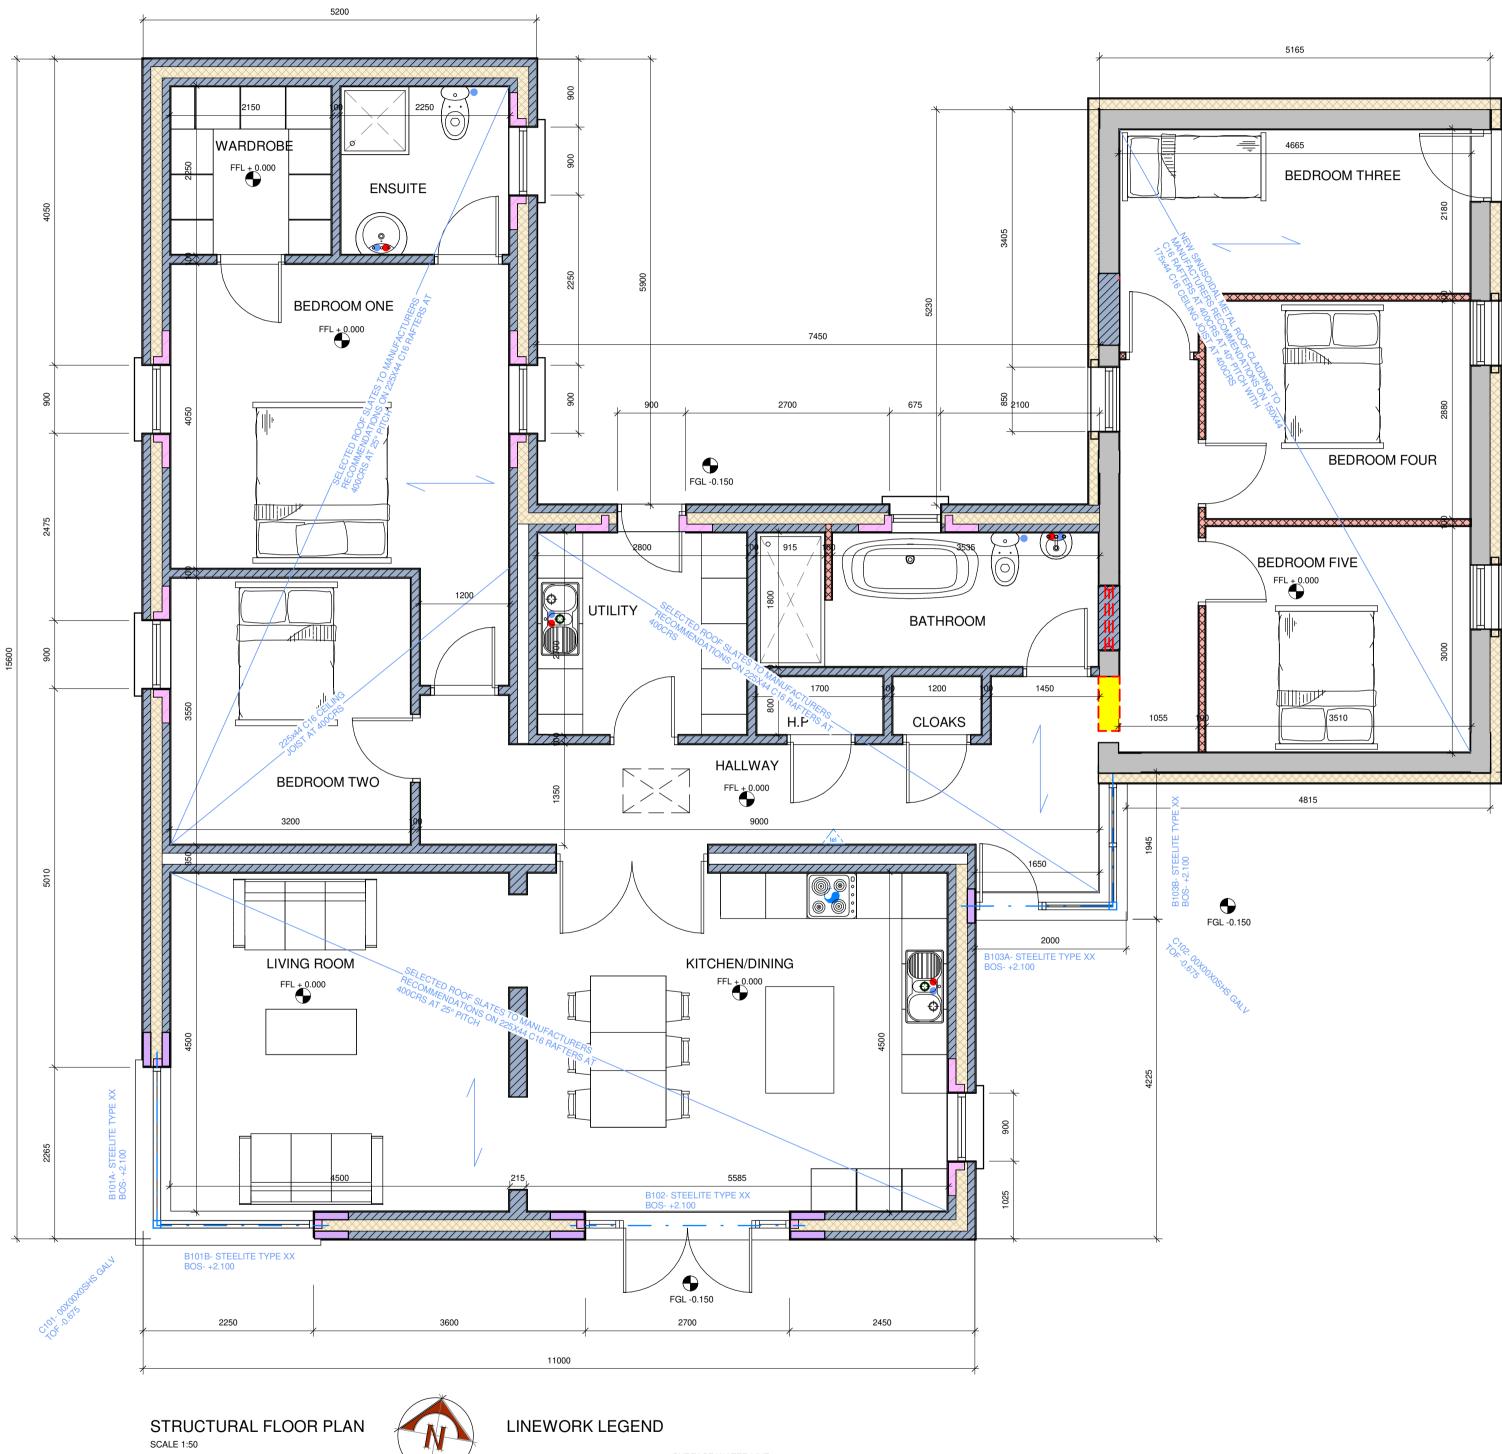
1.1

LINEWORK LEGEND

SURFACE WATER LINE RADON PIPE FROM SUMP ------ - ----- STEEL BEAMS

ELECTRICAL WIRE

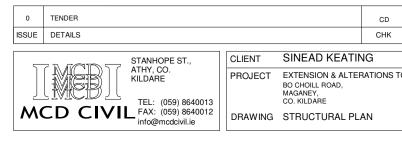

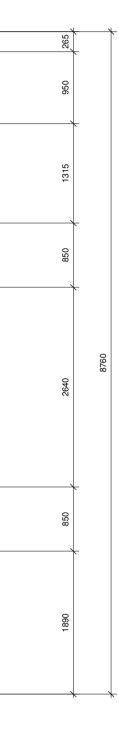

 CD
 JD
 29/07/2021

 CHK
 DRN
 DATE
 CLIENT SINEAD KEATING PROJECT EXTENSION & ALTERATIONS TO EXISTING COTTAGE BO CHOILL ROAD, MAGANEY, CO. KILDARE

IMPORTANT NOTES


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PROJECT NO T20/058 DRAWING NO 02/04
 PROJECT PHASE
 1:50

 TENDER
 DATE

 29/07/2021



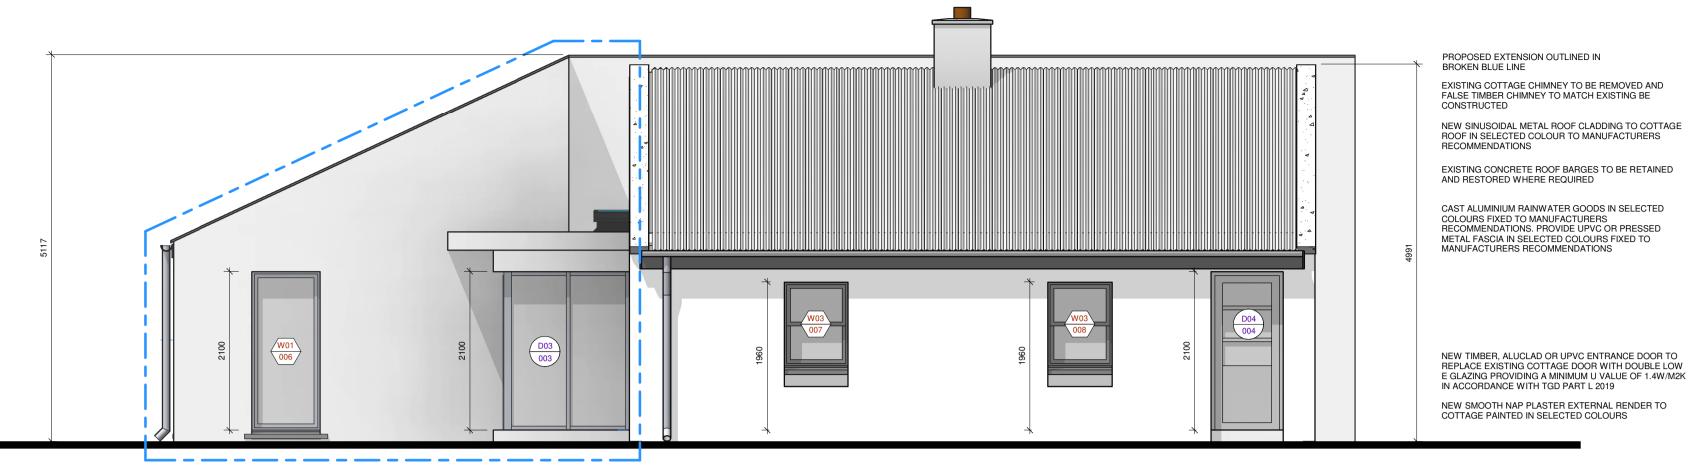


ALUCLAD TILT & TURN WINDOWS WITH TRIPLE LOW E GLAZING PROVIDING A MINIMUM U VALUE OF 1.4W/M2K IN ACCORDANCE WITH TGD PART L 2019 ACCORDANCE WITH TGD PART L 2019 ACCORDANCE WITH TGD PART L 2019

SMOOTH NAP PLASTER EXTERNAL RENDER PAINTED IN SELECTED COLOURS

FRONT ELEVATION EAST 1:50

			WINDOW SCHEDULE	
WINDOW TYPE	WINDOW NO.S	SIZE(WIDTHXDEPTH)	GLAZING	
W01	001, 002, 003, 004, 006	900X2100		ALUCLAD TILT & TURN WINDOW 0.7W/M2K)
W02	005	2250X2100	TRIPLE, SOFT COAT LOW E, ARGON FILLED, CLEAR	ALUCLAD TILT & TURN WINDOW 0.7W/M2K)
W03	007, 008, 009	850X1100	TRIPLE, SOFT COAT LOW E, ARGON FILLED, CLEAR	ALUCLAD TILT & TURN WINDOW 0.7W/M2K)
W04	010	675X2100	TRIPLE, SOFT COAT LOW E, ARGON FILLED, CLEAR	ALUCLAD TILT & TURN WINDOW 0.7W/M2K)
W05	011	780X1080	TRIPLE, SOFT COAT LOW E, ARGON FILLED, CLEAR	VELUX CVP 060090 FLAT ROOFL VALUE 0.83W/MK)

PROPOSED EXTENSION OUTLINED IN BROKEN BLUE LINE

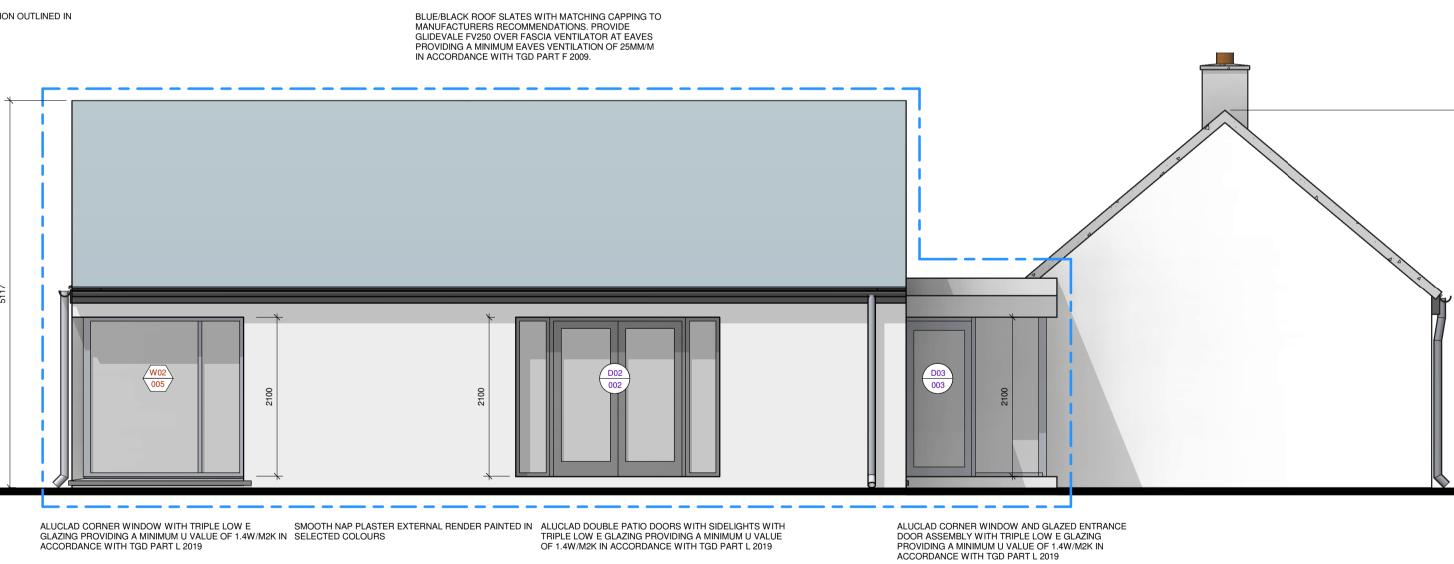


SIDE ELEVATION SOUTH 1:50

PRESSED METAL FASCIA T FLAT ROOF EDGE IN SELECTED RAL COLOURS

NEW TIMBER FRAMED, ALUCLAD OR UPVC CASEMENT WINDOWS TO REPLACE EXISTING COTTAGE WINDOWS WITH DOUBLE LOW E GLAZING PROVIDING A MINIMUM U VALUE OF 1.4W/M2K IN ACCORDANCE WITH TGD PART L 2019


			DOOR SCHEDULE
DOOR TYPE	DOOR NO.' S	SIZE(WIDTHXDEPTH)	NOTES
D01	001	900X2100	ALUCLAD GLAZED DOOR. TRIPLE LOW E GLAZING, CLEAR, STAINLESS STEEL IRONN
D02	002	2700X2100	ALUCLAD GLAZED DOUBLE PATIO DOORS WITH SIDELIGHTS. TRIPLE LOW E GLAZIN
D03	003	875X2050	ALUCLAD GLAZED DOOR & CORNER WINDOW. TRIPLE LOW E GLAZING, CLEAR, STA
D04	004	950X2100	ALUCLAD DOOR WITH GLAZED TOP SECTION. TRIPLE LOW E GLAZING, CLEAR, STAI
D05	005, 006, 007, 008, 009, 010, 011, 012, 013, 014, 015	900X2100	MOULDED MDF ENGINEERED INTERNAL SOLID DOOR
D06	016	2000X2100	MOULDED MDF ENGINEERED INTERNAL DOUBLE DOORS

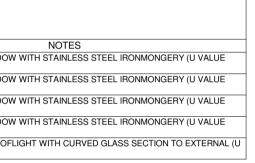

0	TENDER				CD	JD	29/07/2021
ISSUE	DETAILS				СНК	DRN	DATE
•							
		OPE ST.,	CLIENT	SINEAD KEATIN	IG		
			PROJECT	EXTENSION & ALTEF BO CHOILL ROAD, MAGANEY, CO. KILDARE ELEVATIONS	ATIONS TO E	KISTING COTTA	GE

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DATE 29/07/2021

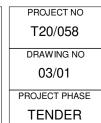

EXISTING COTTAGE CHIMNEY TO BE REMOVED AND FALSE TIMBER CHIMNEY TO MATCH EXISTING B

EXISTING CONCRETE ROOF BARGES TO BE RETAINED AND RESTORED WHERE REQUIRED NEW SMOOTH NAP PLASTER EXTERNAL RENDER TO COTTAGE PAINTED IN SELECTED COLOURS

CONSTRUCTED

MONGERY. NG, CLEAR, STAINLESS STEEL IRONMONGERY. AINLESS STEEL IRONMONGERY. AINLESS STEEL IRONMONGERY.

PROPOSED EXTENSION OUTLINED IN BROKEN BLUE LINE




REAR ELEVATION WEST 1:50

	WINDOW SCHEDULE						
WINDOW TYPE	WINDOW NO.S	SIZE(WIDTHXDEPTH)	GLAZING	NOTES			
W01	001, 002, 003, 004, 006	900X2100	TRIPLE, SOFT COAT LOW E, ARGON FILLED, CLEAR	ALUCLAD TILT & TURN WINDOW WITH STAINLESS STEEL IRONMONGERY (U VALUE 0.7W/M2K)			
W02	005	2250X2100	TRIPLE, SOFT COAT LOW E, ARGON FILLED, CLEAR	ALUCLAD TILT & TURN WINDOW WITH STAINLESS STEEL IRONMONGERY (U VALUE 0.7W/M2K)			
W03	007, 008, 009	850X1100	TRIPLE, SOFT COAT LOW E, ARGON FILLED, CLEAR	ALUCLAD TILT & TURN WINDOW WITH STAINLESS STEEL IRONMONGERY (U VALUE 0.7W/M2K)			
W04	010	675X2100	TRIPLE, SOFT COAT LOW E, ARGON FILLED, CLEAR	ALUCLAD TILT & TURN WINDOW WITH STAINLESS STEEL IRONMONGERY (U VALUE 0.7W/M2K)			
W05	011	780X1080	TRIPLE, SOFT COAT LOW E, ARGON FILLED, CLEAR	VELUX CVP 060090 FLAT ROOFLIGHT WITH CURVED GLASS SECTION TO EXTERNAL (U VALUE 0.83W/MK)			

PROPOSED EXTENSION OUTLINED IN BROKEN BLUE LINE

EXISTING CONCRETE ROOF BARGES TO BE RETAINED AND RESTORED WHERE REQUIRED

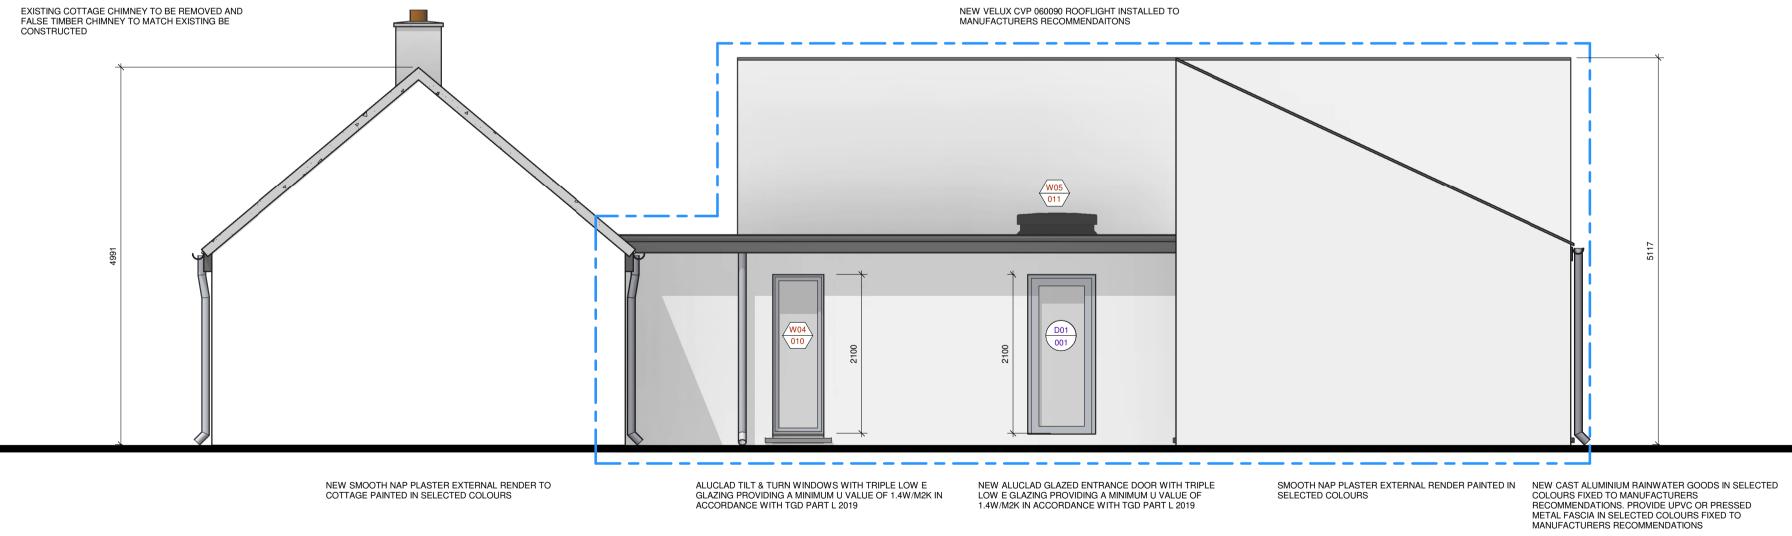

SIDE ELEVATION NORTH 1:50

	DOOR SCHEDULE					
DOOR TYPE	DOOR NO.' S	SIZE(WIDTHXDEPTH)	NOTES			
D01	001	900X2100	ALUCLAD GLAZED DOOR. TRIPLE LOW E GLAZING, CLEAR, STAINLESS STEEL IRONMONGERY.			
D02	002	2700X2100	ALUCLAD GLAZED DOUBLE PATIO DOORS WITH SIDELIGHTS. TRIPLE LOW E GLAZING, CLEAR, STAINLESS STEEL IRONMONGERY.			
D03	003	875X2050	ALUCLAD GLAZED DOOR & CORNER WINDOW. TRIPLE LOW E GLAZING, CLEAR, STAINLESS STEEL IRONMONGERY.			
D04	004	950X2100	ALUCLAD DOOR WITH GLAZED TOP SECTION. TRIPLE LOW E GLAZING, CLEAR, STAINLESS STEEL IRONMONGERY.			
D05	005, 006, 007, 008, 009, 010, 011, 012, 013, 014, 015	900X2100	MOULDED MDF ENGINEERED INTERNAL SOLID DOOR			
D06	016	2000X2100	MOULDED MDF ENGINEERED INTERNAL DOUBLE DOORS			
D06	016	2000X2100	MOULDED MDF ENGINEERED INTERNAL DOUBLE DOORS			

0	TENDER					
ISSUE	DETAILS					
	STANHOPE ST.,	CLIENT				
	ATHY, CO. Kildare					
1						
M	TEL: (059) 8640013 FAX: (059) 8640012 info@mcdcivil.ie	DRAWING				

CD JD 29/07/2021 СНК DRN DATE SINEAD KEATING EXTENSION & ALTERATIONS TO EXISTING COTTAGE BO CHOILL ROAD, MAGANEY, CO. KILDARE i ELEVATIONS

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 THE CONTRACTOR OR PRESONS) RESPONSIBLE FOR CARPYING OUT THE WORKS SHALL CHECK THE ACCURACY OF THE DRAWINGS AND AWY DETAILSINISTRUCTIONS: SPECIFICATIONS THEREON AGAINST THE SITE, ITS GEOMETERY AND CONDITIONS, PRIOR TO THE CARRYING OUT OF THE WORKS.

PROJECT NO T20/058 DRAWING NO 03/02 PROJECT PHASE TENDER

SCALE 1 : 50

DATE 29/07/2021

ELECTRICAL LEGEND

LIP44	13 AMP TWIN SWITCHED SOCKET OUTLET 13 AMP SINGLE SWITCHED SOCKET OUTLET (IPXX RATED) SHAVER SOCKET
	CONSUMER UNIT / FUSE BOARD
	ELECTRICAL METER
	POWER SHOWER
СК	COOKER POINT
IM	IMMERSION
TV	TELEVISION OUTLET
tel	TELEPHONE OUTLET
RS	ROOM THERMOSTAT
6	SINGLE POLE SWITCH
$\vdash \otimes$	WALL MOUNTED LUMINAIRE (IP RATED)
$\vdash \bigcirc$	WALL MOUNTED LUMINAIRE
$\mathbf{\overline{\mathbf{N}}}$	PENDANT LUMINAIRE
	RECESSED LED LUMINAIRE
\bullet	OPTICAL TYPE SMOKE DETECTOR
\oplus	RATE OF RISE HEAT DETECTOR
-@-	CARBON MONOXIDE DETECTOR
6	MECHANICAL EXTRACTION FAN
EV	ELECTRIC CAR CAR POINT

PLUMBING LEGEND

AIR SOURCE HEAT PUMP INSTALLED TO MANUFACTURERS RECOMMENDATIONS

UNDERFLOOR HEATING INCORPORATED IN CONCRETE SCREED COLD MAINS WATER FEED COLD STORAGE WATER FEED HOT WATER STORAGE FEED

LINEWORK LEGEND

 SURFACE WATER LINE
 FOUL SEWER LINE
 RADON PIPE FROM SUM
 STEEL BEAMS
 ELECTRICAL WIRE

OUL SEWER LINE ADON PIPE FROM SUMP FEEL BEAMS ELECTRICAL WIRE

PROVIDE PENDENT LIGHTS AND 3NO. DOUBLE PLUG SOCKETS TO ATTIC SPACE IN LOCATIONS SELECTED BY CLIENT

INSULATED ATTIC HATCH DOOR WITH FOLDING ATTIC LADDER INSTALLED TO MANUFACTURERS RECOMMENDATIONS. PROVIDE 340LTS CAPACITY WATER CISTERN IN ATTIC SPACE ABOVE BEDROOM TWO AND HALLWAY, CISTERN & PIPEWORK TO BE WELL INSULATED. PROVIDE INSULATED NON AIRTIGHT LID TO CISTERN. CISTERN TO BE SUPPORTED ON PLYWOOD BASE ON PRIMARY, SECONDARY AND SPREADER BEAMS DESIGNED IN ACCORDANCE WITH I.S.193: 1986



SERVICES FLOOR PLAN



ROOM NAME	SOC	KETS		LIGHTS	3	C	COMMS ALARMS			APPLIANCE OUTLETS					
	SINGLE SWITCHED	DOUBLE	CEILING ROSE		WALL LIGHTS		TV OUTLET	SD	HD		IMMERSION	COOKER	SHOWER	ROOM STAT	MECH EXTRACT
HALLWAY		4	5			1		1		1				2	
UTILITY		4	1					1		1					
BATHROOM			0	3									1		1
KITCHEN/DINING		7	4	6					1			1			1
LIVING ROOM		5	1											1	
WARDROBE		3	0	2											
ENSUITE			1										1		1
BEDROOM ONE		4	1				1	1		1				1	
BEDROOM TWO		3	1				1	1		1					
CLOAKS			1												
BEDROOM THREE		3	1				1	1		1					
BEDROOM FOUR		3	1				1	1		1					
BEDROOM FIVE		3	1				1	1		1				0	
H.P			1								0				

BATHROOM ZONE 3- UNDERFLOOR HEATING TO MANUFACTURERS DESIGN, DCW FEED TO WHB, W.C, SHOWER & BATH, DHW FEED TO WHB, W.C & BATH BEDROOM FIVE ZONE 4- UNDERFLOOR HEATING TO MANUFACTURERS DESIGN BEDROOM FOUR ZONE 4- UNDERFLOOR HEATING TO MANUFACTURERS DESIGN BEDROOM ONE ZONE 2- UNDERFLOOR HEATING TO MANUFACTURERS DESIGN, DIGITAL PROGRAMMABLE ROOM STAT BEDROOM THREE ZONE 4- UNDERFLOOR HEATING TO MANUFACTURERS DESIGN, DIGITAL PROGRAMMABLE ROOM STAT BEDROOM TWO ZONE 2- UNDERFLOOR HEATING TO MANUFACTURERS DESIGN, DIGITAL PROGRAMMABLE ROOM STAT BEDROOM TWO ZONE 2- UNDERFLOOR HEATING TO MANUFACTURERS DESIGN CLOAKS ZONE 3- UNDERFLOOR HEATING TO MANUFACTURERS DESIGN ENSUITE ZONE 2- UNDERFLOOR HEATING TO MANUFACTURERS DESIGN H.P ZONE 3- UNDERFLOOR HEATING TO MANUFACTURERS DESIGN HALLWAY ZONE 3- UNDERFLOOR HEATING TO MANUFACTURERS DESIGN, DHW FEED TO WHB, W.C & SHOWER H.P ZONE 3- UNDERFLOOR HEATING TO MANUFACTURERS DESIGN, DIGITAL PROGRAMMABLE ROOM STAT(ZONE 3 & ZONE 4) KITCHEN/DINING ZONE 1- UNDERFLOOR HEATING TO MANUFACTURERS DESIGN, DIGITAL PROGRAMMABLE ROOM STAT LIVING ROOM ZONE 1- UNDERFLOOR HEATING TO MANUFACTURERS DESIGN, DCW MAINS FEED TO SINK, DHW FEED TO SINK LIVING ROOM ZONE 1- UNDERFLOOR HEATING TO MANUFACTURERS DESIGN, DCW MAINS FEED TO SINK, DHW FEED TO SINK LI	BEDROOM FIVE BEDROOM FOUR BEDROOM ONE	BATH ZONE 4- UNDERFLOOR HEATING TO MANUFACTURERS DESIGN ZONE 4- UNDERFLOOR HEATING TO MANUFACTURERS DESIGN
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KITCHEN/DINING ZONE 1- UNDERFLOOR HEATING TO MANUFACTURERS DESIGN, DCW MAINS FEED TO SINK, DHW FEED TO SINK LIVING ROOM ZONE 1- UNDERFLOOR HEATING TO MANUFACTURERS DESIGN, DIGITAL PROGRAMMABLE ROOM STAT UTILITY ZONE 3- UNDERFLOOR HEATING TO MANUFACTURERS DESIGN, DCW MAINS FEED TO SINK, DHW FEED TO SINK, DCW FEED TO WASHIN	H.P	ZONE 3- UNDERFLOOR HEATING TO MANUFACTURERS DESIGN
LIVING ROOM ZONE 1- UNDERFLOOR HEATING TO MANUFACTURERS DESIGN, DIGITAL PROGRAMMABLE ROOM STAT UTILITY ZONE 3- UNDERFLOOR HEATING TO MANUFACTURERS DESIGN, DCW MAINS FEED TO SINK, DHW FEED TO SINK, DCW FEED TO WASHIN	HALLWAY	ZONE 3- UNDERFLOOR HEATING TO MANUFACTURERS DESIGN, DIGITAL PROGRAMMABLE ROOM STAT(ZONE 3 & ZONE 4)
UTILITY ZONE 3- UNDERFLOOR HEATING TO MANUFACTURERS DESIGN, DCW MAINS FEED TO SINK, DHW FEED TO SINK, DCW FEED TO WASHIN	KITCHEN/DINING	ZONE 1- UNDERFLOOR HEATING TO MANUFACTURERS DESIGN, DCW MAINS FEED TO SINK, DHW FEED TO SINK
	LIVING ROOM	ZONE 1- UNDERFLOOR HEATING TO MANUFACTURERS DESIGN, DIGITAL PROGRAMMABLE ROOM STAT
		ZONE 3- UNDERFLOOR HEATING TO MANUFACTURERS DESIGN, DCW MAINS FEED TO SINK, DHW FEED TO SINK, DCW FEED TO WASHING MACHINE, CONTROL GEAR FOR HEAT PUMP, MANIFOLD FOR HEATING SYSTEM, HEAT PUMP INTERNAL UNIT/WATER STORAGE
WARDROBE ZONE 2- UNDERFLOOR HEATING TO MANUFACTURERS DESIGN	WARDROBE	ZONE 2- UNDERFLOOR HEATING TO MANUFACTURERS DESIGN

	SANITARY	' FURNITURE	SCHEDULE	
ROOM NAME	WASH HAND BASIN	W.C	SHOWER	BATH
BATHROOM	1	1	1	1
ENSUITE	1	1	1	

0	TENDER				CD	JD	29/07/2021
ISSUE	DETAILS				СНК	DRN	DATE
			CLIENT	SINEAD KEATIN	١G		
		ATHY, CO. KILDARE TEL: (059) 8640013 FAX: (059) 8640012 info@mcdcivil.ie	PROJECT	EXTENSION & ALTEF BO CHOILL ROAD, MAGANEY, CO. KILDARE SERVICES PLAN	RATIONS TO E	KISTING COTTA	GE

IMPORTANT NOTES


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PROJECT NO T20/058 DRAWING NO 02/05
 PROJECT PHASE
 1:50


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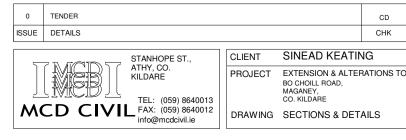
 29/07/2021





CROSS SECTION A-A

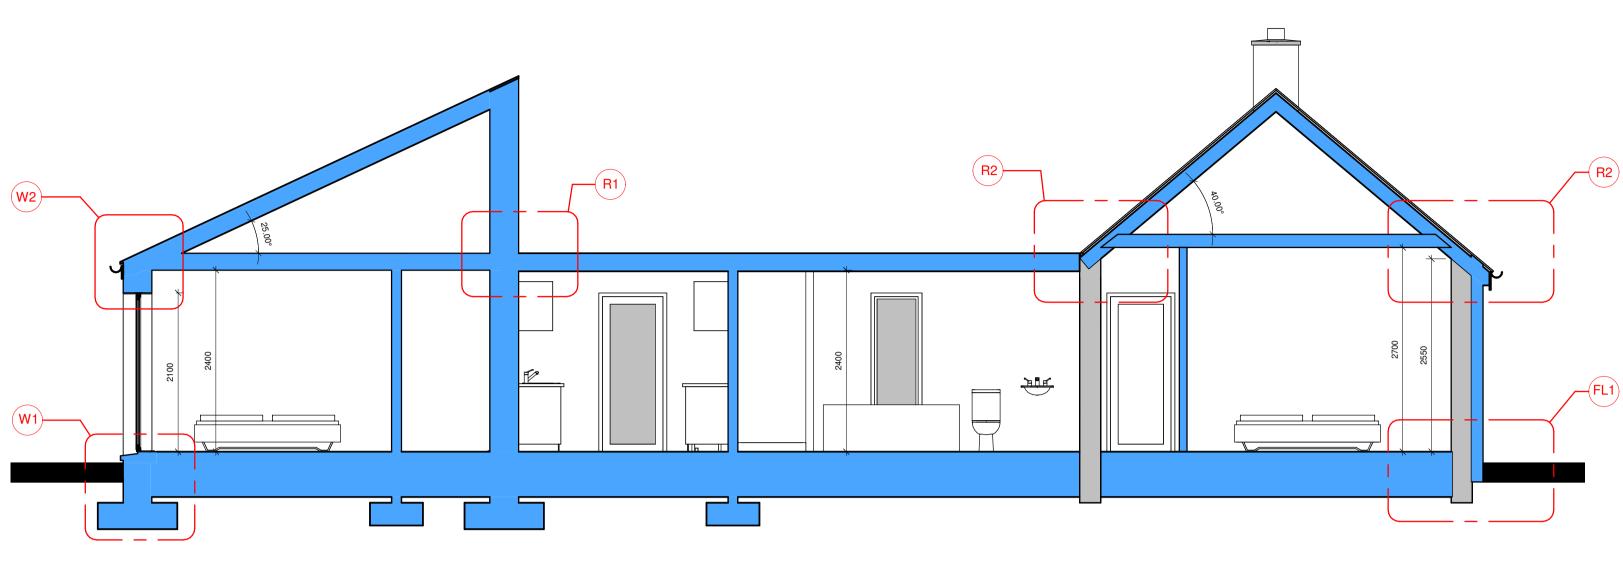

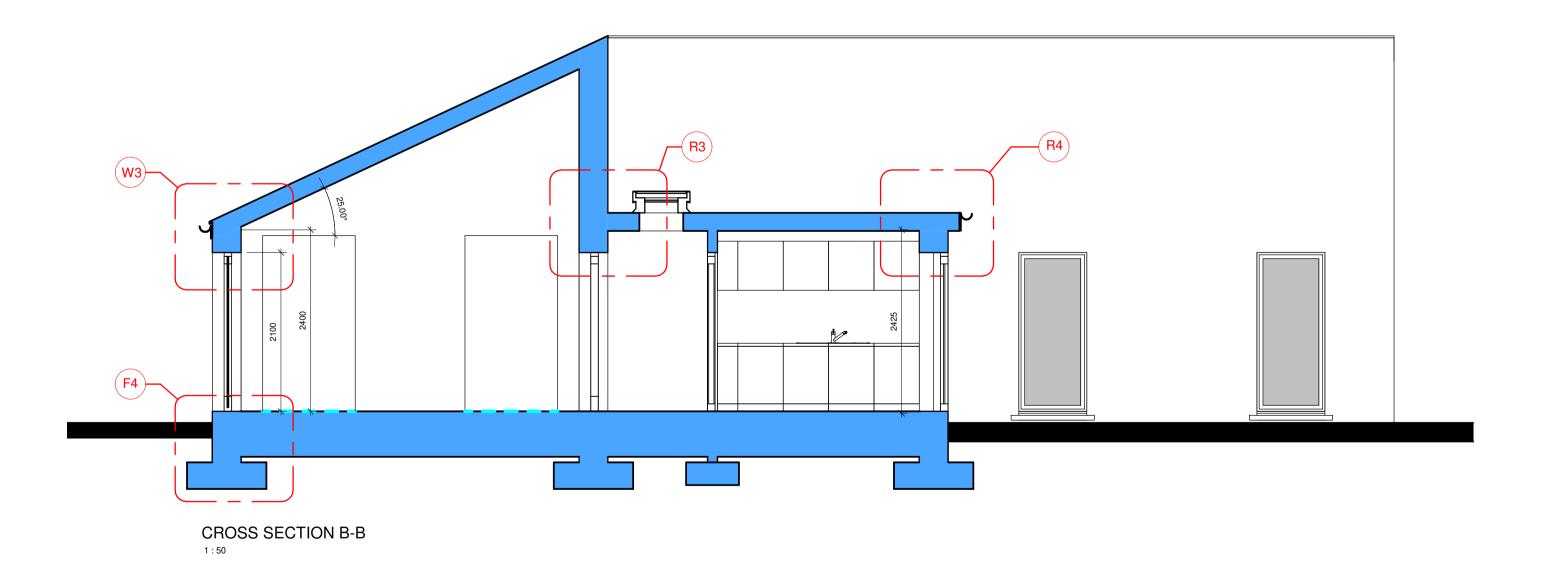

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 CD
 JD
 29/07/2021

 CHK
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 CLIENT SINEAD KEATING PROJECT EXTENSION & ALTERATIONS TO EXISTING COTTAGE BO CHOILL ROAD, MAGANEY, CO. KILDARE

IMPORTANT NOTES


INFORTATIONS AND ANY DEVICES STATUS ONLY TO THE NAMED CLIENT AND THEIR REPRESENTATIVES TO SUCH EXTERT AS TO ALLOW THE SPECIFIC WORKS ON THE SPECIFIED SITE TO BE CONSTRUCTED. THIS LICENCE DOES NOT EXTEND TO ANY OTHER WORKS. ON THE SPECIFIED SITE TO BE CONSTRUCTED. THIS LICENCE DOES NOT EXTEND TO ANY OTHER WORKS. ON THE SPECIFIED SITE TO BE CONSTRUCTED. THIS LICENCE DOES NOT EXTEND TO ANY OTHER WORKS. ON THE SPECIFIED SITE TO BE CONSTRUCTED. THIS LICENCE DOES NOT EXTEND TO ANY OTHER WORKS. ON THE SPECIFIED SITE TO BE CONSTRUCTED. THIS LICENCE DOES NOT EXTEND TO ANY OTHER WORKS. NOTIFY THE BRUIDING REGULATIONS, SAFETY HEALTH A WELFARE AT WORK (CONSTRUCTION REGULATIONS) AND APPLICABLE IS, BS AND EN STANDARDS. WORKS REFEREND TO ANT INS DRAWING WICH DO NOT MEET THE REQUIREMENTS OF THE ABOVE STANDARDS OR ARE LIKELY TO CAUSE HAZARDOUS WORKING CONDITIONS SHALL BE BROUGHT TO THE ATTENTION OF THE ENGINEER IMMEDIATELY AND PRIOR TO THE WORK(S) BEING CARRIED OUT. IN CARRYING AULT THE WORKS SHALL CHECK THE ACCURACY OF THE DRAWINGS AND ANY DETAILSINGTRUCTONS/SPECIFICATIONS THEREON AGAINST THE STRE, ITS GEOMETERY AND CONDITIONS, PRIOR TO THE CARRYING OUT OF THE WORKS.


PROJECT NO T20/058 DRAWING NO 04/01
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 TENDER
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 29/07/2021






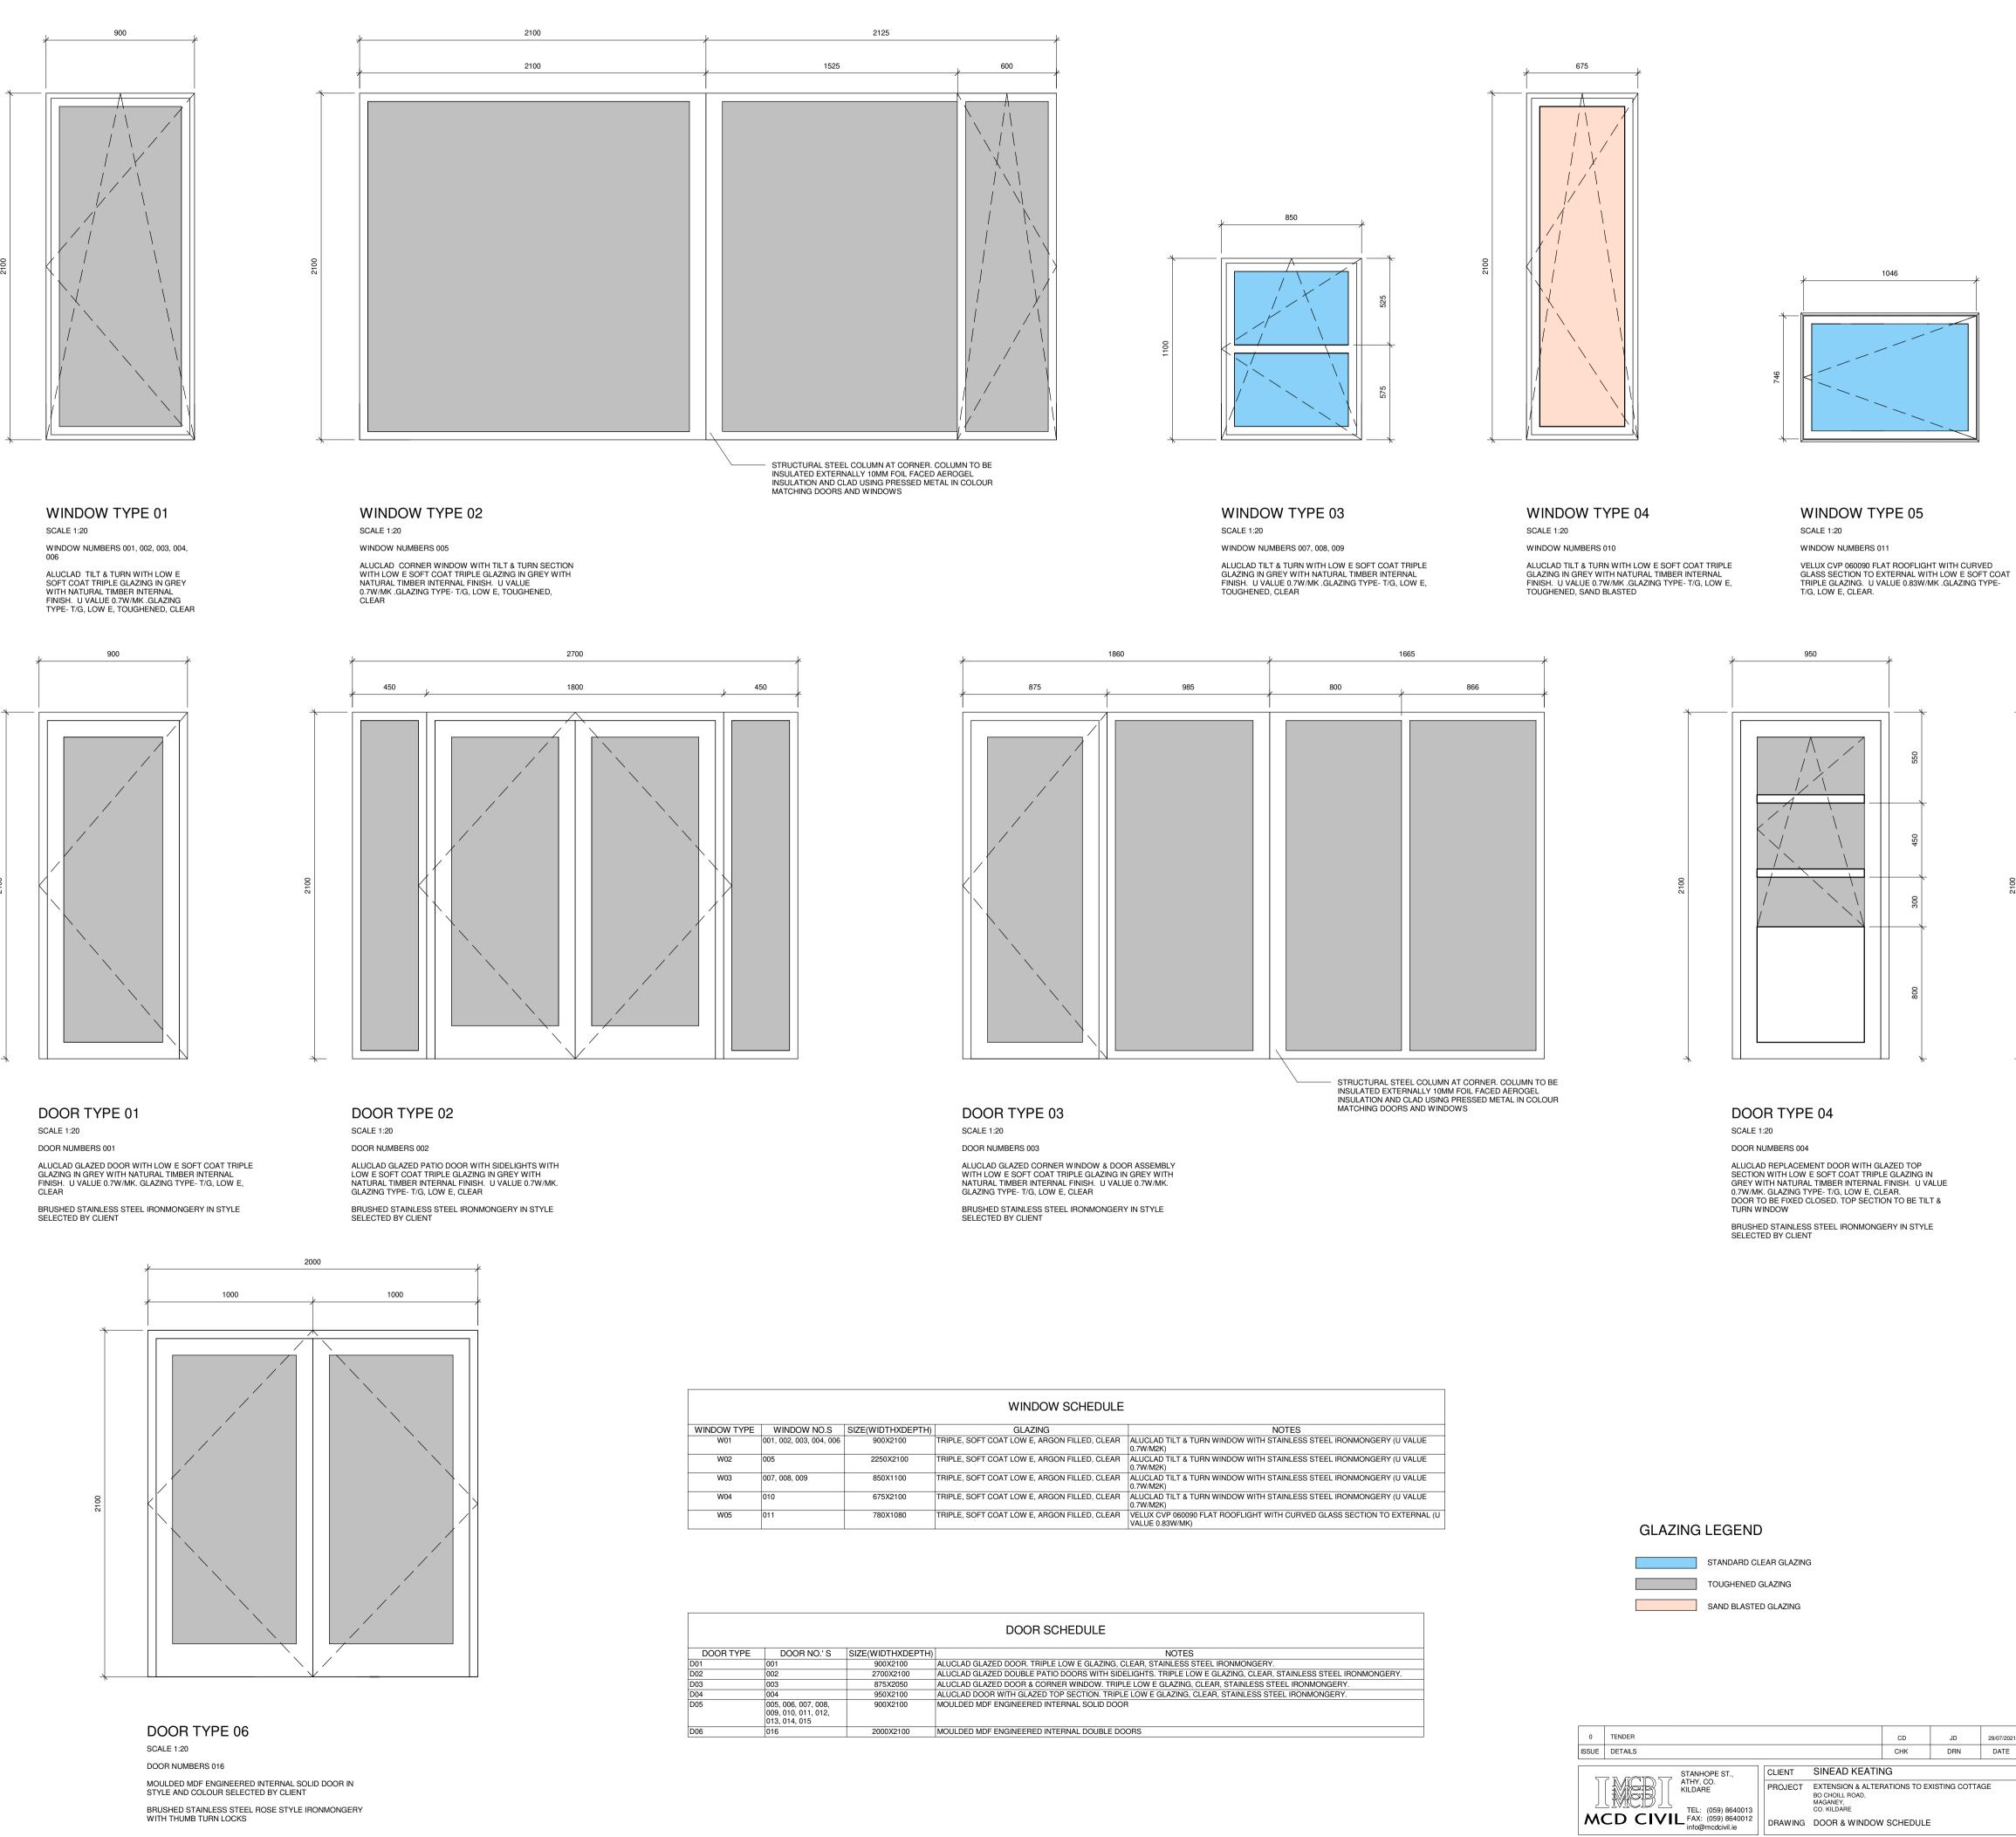

BRUSHED STAINLESS STEEL ROSE STYLE IRONMONGERY WITH THUMB TURN LOCKS

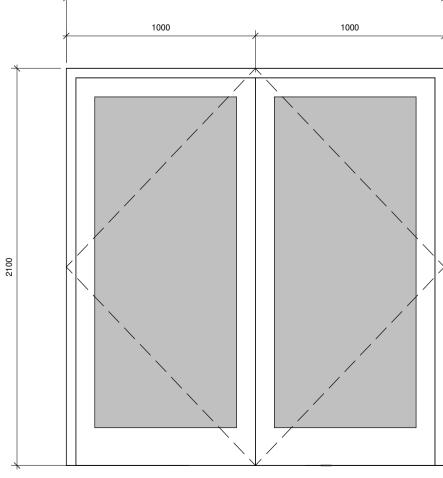WINDOW TYPE
W01
W02
W03
W04
W05

DOOR TYPE
01
02
03
04
05

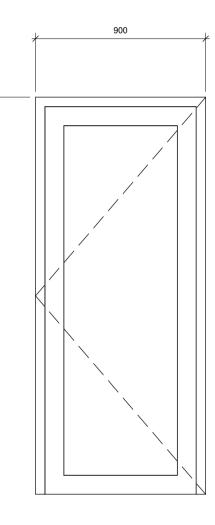

DOOR TYPE 05 SCALE 1:20 DOOR NUMBERS 005, 006, 007, 008, 009, 010, 011, 012, 013, 014, 015 MOULDED MDF ENGINEERED INTERNAL SOLID DOOR IN STYLE AND COLOUR SELECTED BY CLIENT BRUSHED STAINLESS STEEL ROSE STYLE IRONMONGERY WITH THUMB TURN LOCKS

CD JD 29/07/2021								
CHK DRN DATE								
SINEAD KEATIN	NG							
EXTENSION & ALTERATIONS TO EXISTING COTTAGE BO CHOILL ROAD, MAGANEY, CO. KILDARE								
DOOR & WINDOW SCHEDULE								

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PROJECT NO T20/058 DRAWING NO 05/01 PROJECT PHASE TENDER



As indicated ^E 29/07/2021